SCS PROJECT: FIBERSHIELD V STANDARD TEMPLATE



ATTENTION: TECHNICAL REQUIREMENTS FOR THIS PROJECT



 			
No	DESCRIPTION	REQUIREMENT	RESPONSIBILITY
1	WORKS DONE BY OTHERS	ALL DETAILS PERTAINING TO WORK BY OTHERS IS AN ADVISEMENT ONLY AND IT IS THE RESPONSIBILITY OF THE SUPPLIER AND INSTALLER OF THE ITEM/S TO CONFIRM COMPLIANCE TO ITS SUITABILITY FOR THE PURPOSE AND TO CERTIFY ITS COMPLIANCE TO THE REQUIRED FRL TO THE SATISFACTION OF THE FE OR CERTIFIER.	BUILDER, ARCHITECT, OTHER TRADES
2	SHOP DRAWINGS	APPROVAL OF SHOP DRAWINGS (SIGNITURE AND DATE) IS REQUIRED TO BE RETURNED TO SMOKE CONTROL SYSTEM BEFORE MANUFACTURE CAN COMMENCE.	BUILDER, ARCHITECT
3	DELIVERIES TO SITE	IF REQD, FORKLIFT TO BE MADE AVAILABLE.	BUILDER
4	VERTICAL MOVEMENT OF PRODUCT	IF REQD, CRANE SHALL BE AVAILABLE TO SMOKE CONTROL SYSTEMS AT AGREED TIME OF DELIVERY. IF THIS IS NOT AVAILABLE, THIS MAY INCUR EXTRA CHARGES.	BUILDER
5	STORAGE	SUFFICIENT CLEAR FLOOR SPACE TO BE MADE AVAILABLE IMMEDIATELY ADJACENT TO EACH INSTALLATION LOCATION.	BUILDER
6	ACCESS TO WORKFACE (INSTALLATION)	REASONABLY ADEQUATE WORKING AREA REQD., MIN 500mm FROM SYSTEM TO STRUCTURE IS IDEAL. SUBJECT TO SITE CONDITIONS.	BUILDER
7	BALUSTRADES (WHERE PRESENT)	WHERE APPLICABLE, BALLUSTRADES MUST NOT INTERFERE WITH THE OPERATION OF CURTAIN IN ANY WAY. MIN. 100mm FROM SYSTEM TO BALUSTRADE OFFSET IS IDEAL.	BUILDER
8	ACCESS PANELS (INSTALATION WITHIN CEILING CAVITY)	450X450 NOM. ACCESS PANELS TO BE PROVIDED. THREE EQUALY SPACED PANELS (ONE ON EITHER END AND ONE DEAD CENTRE) WILL BE REQUIRED WHERE ACCESS TO HEAD BOX IS RESTRICTED. MAY NOT BE REQD. WHERE REMOVABLE GRID CEILING ALLOWS FOR CLEAR ACCESS TO CURTAIN CONTROLLERS.	BUILDER, CEILING CONTRACTOR
9	POWER REQUIREMENTS	240 VOLT 10 AMP GPO TO BE LOCATED NO MORE THAN 1m AWAY FROM NOMINATED LOCATION OF CURTAIN CONTROLLERS.	BUILDER, ELECTRICAL
10	ALARM SIGNAL, ACTIVATION	0 VOLT NORMALLY CLOSED CONTACT (OPEN ON ALARM) TO BE PROVIDED WITHIN 1 METRE OF CURTAIN CONTROLLER.	BUILDER, ELECTRICAL, FIRE
11	PRESSURISATION, EXHAUST SYSTEMS	IMPORTANT: BALANCING TO CONSIDER AFFECTS OF CURTAINS 50 PA MAX. PRESSURE DIFFERENTIAL STRONGLY RECOMMENDED.	BULDER, MECHANICAL SERVICES
12	TUNING	ALL SCAFFOLDING & OTHER TRADES TO BE CLEAR 2 DAYS PRIOR TO TUNING & COMMISSIONING.	BUILDER
13	COMMISSIONING STAGE 1	PRACTICAL COMPLETION TESTS: PERMANENT POWER & ALARMS CONNECTED FOR DRY RUN PRIOR TO CSC. CURTAINS MUST BE ISOLATED DURING INDIVIDUAL COMMISSIONING OF OTHER ESSENTIAL SERVICES. (PRODUCT LOCKED IN OPEN POSITION AFTER TESTING)	SMOKE CONTROL SYSTEMS & BUILDER
14	COMMISSIONING STAGE 2	COORDINATED SERVICES COMMISSIONING (CSC)	SMOKE CONTROL SYSTEMS
15	COMMISSIONING STAGE 3	WITNESS TESTING, FINAL COMMISSIONING & HANDOVER	SMOKE CONTROL SYSTEMS
Щ	0.7.0=0		U.U.E. 10

DIFFERENTIAL PRESSURE					
DILLEKERITA	AL PRESSURE				
OPENING SIZE AREA	Δ Pa				
100m²	50Pa				
50m ²	100Pa				

PRODUCT SPECIFICATIONS							
SYSTEM	COMPONENT	MATERIALS	FRL	COLOUR/FINISH			
	FABRIC	FABRIC 1100°C RATED	-/120/-	BOTTOM BAR		SPECIAL ORDER STAINLESS STEEL AVAILABLE	
FIBERSHIELD V	SIDE GUIDES	GALVANISED STEEL		-/120/-	-/120/- SIDE GUID	SIDE GUIDES	
	HEAD BOX & BOTTOM BAR	GALVANISED STEEL		HEAD BOX		POWDER COATING IN STANDARD RAL COLOURS	

DRAWING INDEX				
SHEET	DESCRIPTION	REV		
0001	COVER SHEET	-		
0002	3D INDICATIVE VIEW	-		
0003	FRONT ELEVATION	-		
0004	SIDE ELEVATION - HEADBOX MOUNTING OPTIONS	-		
0005	PLAN VIEW - SIDEGUIDE MOUNTING OPTIONS	-		
0006	CORNER POST DETAIL	-		
0007	BOTTOM BAR OPTIONS	-		
0008	OBSTRUCTION SENSORS	-		

THIS DRAWING IS COPYRIGHT AND THE PROPERTY OF THE AUTHOR, AND MUST NOT BE RETAINED, COPIED OR USED WITHOUT THE AUTHORITY OF SMOKE CONTROL SYSTEMS PTY. LTD.

DO NOT SCALE FROM DRAWING, USE PROVIDED DIMENSIONS ONLY.
ALL DISCREPENCIES MUST BE BROUGHT TO THE ATTENTION OF AUTHOR.
SMOKE CONTROL SYSTEMS DO NOT TAKE RESPONSIBILITY OF MEASUREMENTS

Dey	CHK	REASON	DATE
-	AC	FOR APPROVAL	01/09/2020

DISCLAIMER

Information given in Smokecontrol.com.au and publications for Download are given to the best of our knowledge and IN GOOD FAITH. SMOKE CONTROL IS NOT RESPONSIBLE IF RECIPIENTS OF TEST REPORTS, ASSESSMENTS OR LITERATURE MISINTERPRET THE CONTENTS AND WRONGLY USE PRODUCTS BASED ON THOSE MISINTERPRETATIONS. NO LIABILITY IS ACCEPTED FOR ERROR OMISSIONS IN THIS WEB SITE OR OUR DOCUMENTS. IN THE INTERESTS OF IMPROVEMENTS AND CONTINUED DEVELOPMENT SMOKE CONTROL RESERVES THE RIGHT TO CHANGE SPECIFICATION

INFORMATION COPY ONLY



WWW.SMOKECONTROL.COM.AU WWW.SMOKECONTROL.CO.NZ WWW.SMOKECONTROL.COM

FIBERSHIELD V STANDARD TEMPLATE

AUSTRALIAN HEADOFFICE PHONE: 1300 665 471

PHONE: 09 300 1980 INFO@SMOKECONTROL.CO.NZ

CLIENT

PROJECT SCS-FSV


COVER SHEET

SUB SET (CATEGORY) 00 - SPECIFICATIONS DRAWING NUMBER REV SCS-FSV-0001

DRAWN BY ISSUE STATUS: FOR INFORMATION START DATE SCALE AS SHOWN 01/09/2020

<<< 594mm

FIBERSHIEL V - PREMIUM FIRE CURTAIN

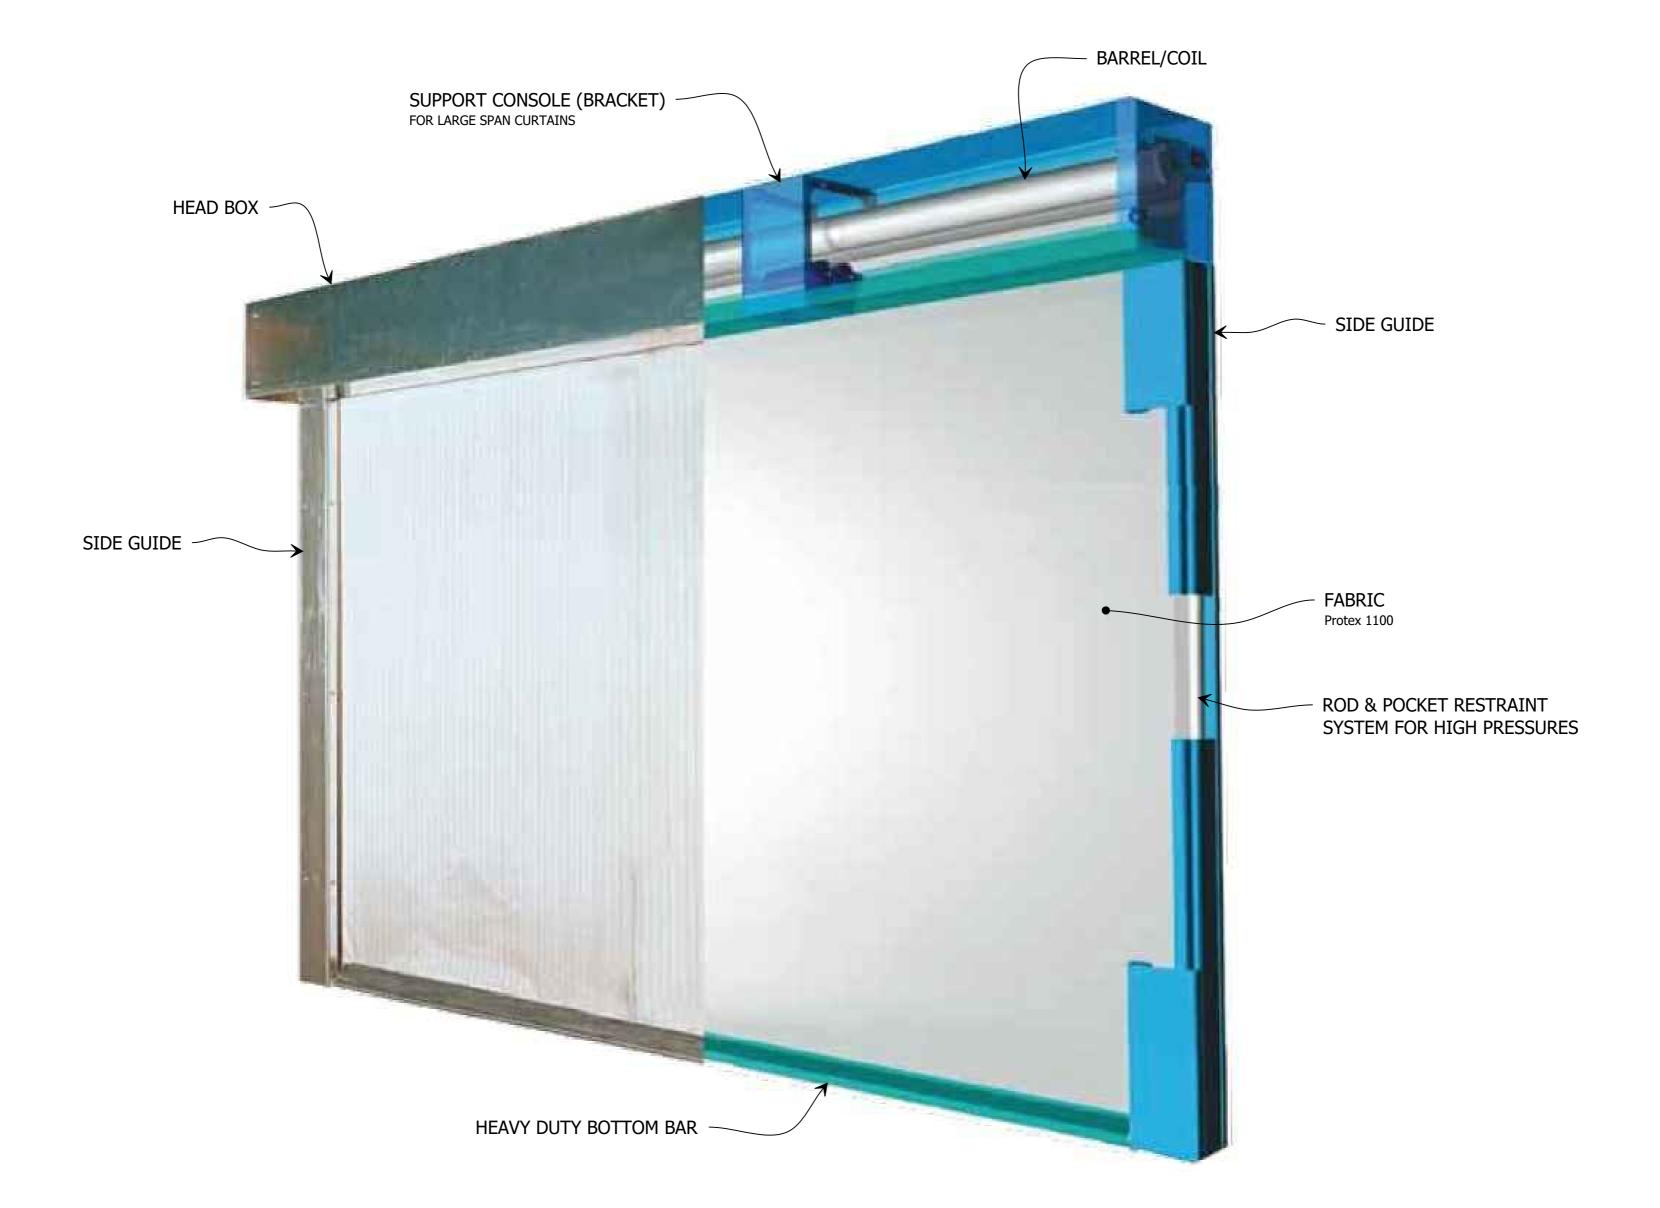

3D VIEW FIBERSHIELD V - PREMIUM FIRE CURTAIN

- THIS DRAWING IS COPYRIGHT AND THE PROPERTY OF THE AUTHOR, AND MUST NOT BE RETAINED, COPIED OR USED WITHOUT THE AUTHORITY OF SMOKE CONTROL SYSTEMS PTY. LTD.
- CONTROL STSTEMS PTY. LTD.

 DO NOT SCALE FROM DRAWTING, USE PROVIDED DIMENSIONS ONLY.
 ALL DISCREPENCIES MUST BE BROUGHT TO THE ATTENTION OF AUTHOR.

 SMOKE CONTROL SYSTEMS DO NOT TAKE RESPONSIBILITY OF MEASUREMENTS
 PROVIDED BY OTHERS.

٠	CHK	REASON	DATE
	AC	FOR APPROVAL	01/09/2020

DISCLAIMER

INFORMATION GIVEN IN SMOKECONTROL.COM.AU AND PUBLICATIONS FOR DOWNLOAD ARE GIVEN TO THE BEST OF OUR KNOWLEDGE AND IN GOOD FAITH. SMOKE CONTROL IS NOT RESPONSIBLE IF RECIPIENTS OF TEST REPORTS, ASSESSMENTS OR LITERATURE MISINTERPRET THE CONTENTS AND WRONGLY USE PRODUCTS BASED ON THOSE MISINTERPRETATIONS. NO LIABILITY IS ACCEPTED FOR ERROR OMISSIONS IN THIS WEB SITE OR OUR DOCUMENTS. IN THE INTERESTS OF IMPROVEMENTS AND CONTINUED DEVELOPMENT SMOKE CONTROL RESERVES THE RIGHT TO CHANGE SPECIFICATION

INFORMATION COPY ONLY



WWW.SMOKECONTROL.COM.AU WWW.SMOKECONTROL.CO.NZ WWW.SMOKECONTROL.COM

AUSTRALIAN HEADOFFICE PHONE: 1300 665 471

PHONE: 09 300 1980

PROJECT

SCS-FSV FIBERSHIELD V STANDARD TEMPLATE

CLIENT

3D INDICATIVE VIEW


SUB SET (CATEGORY)

00 - SPECIFICATIONS

DRAWING NUMBER

SCS-FSV-0002

ISSUE STATUS: DRAWN BY FOR INFORMATION START DATE SCALE 01/09/2020 AS SHOWN

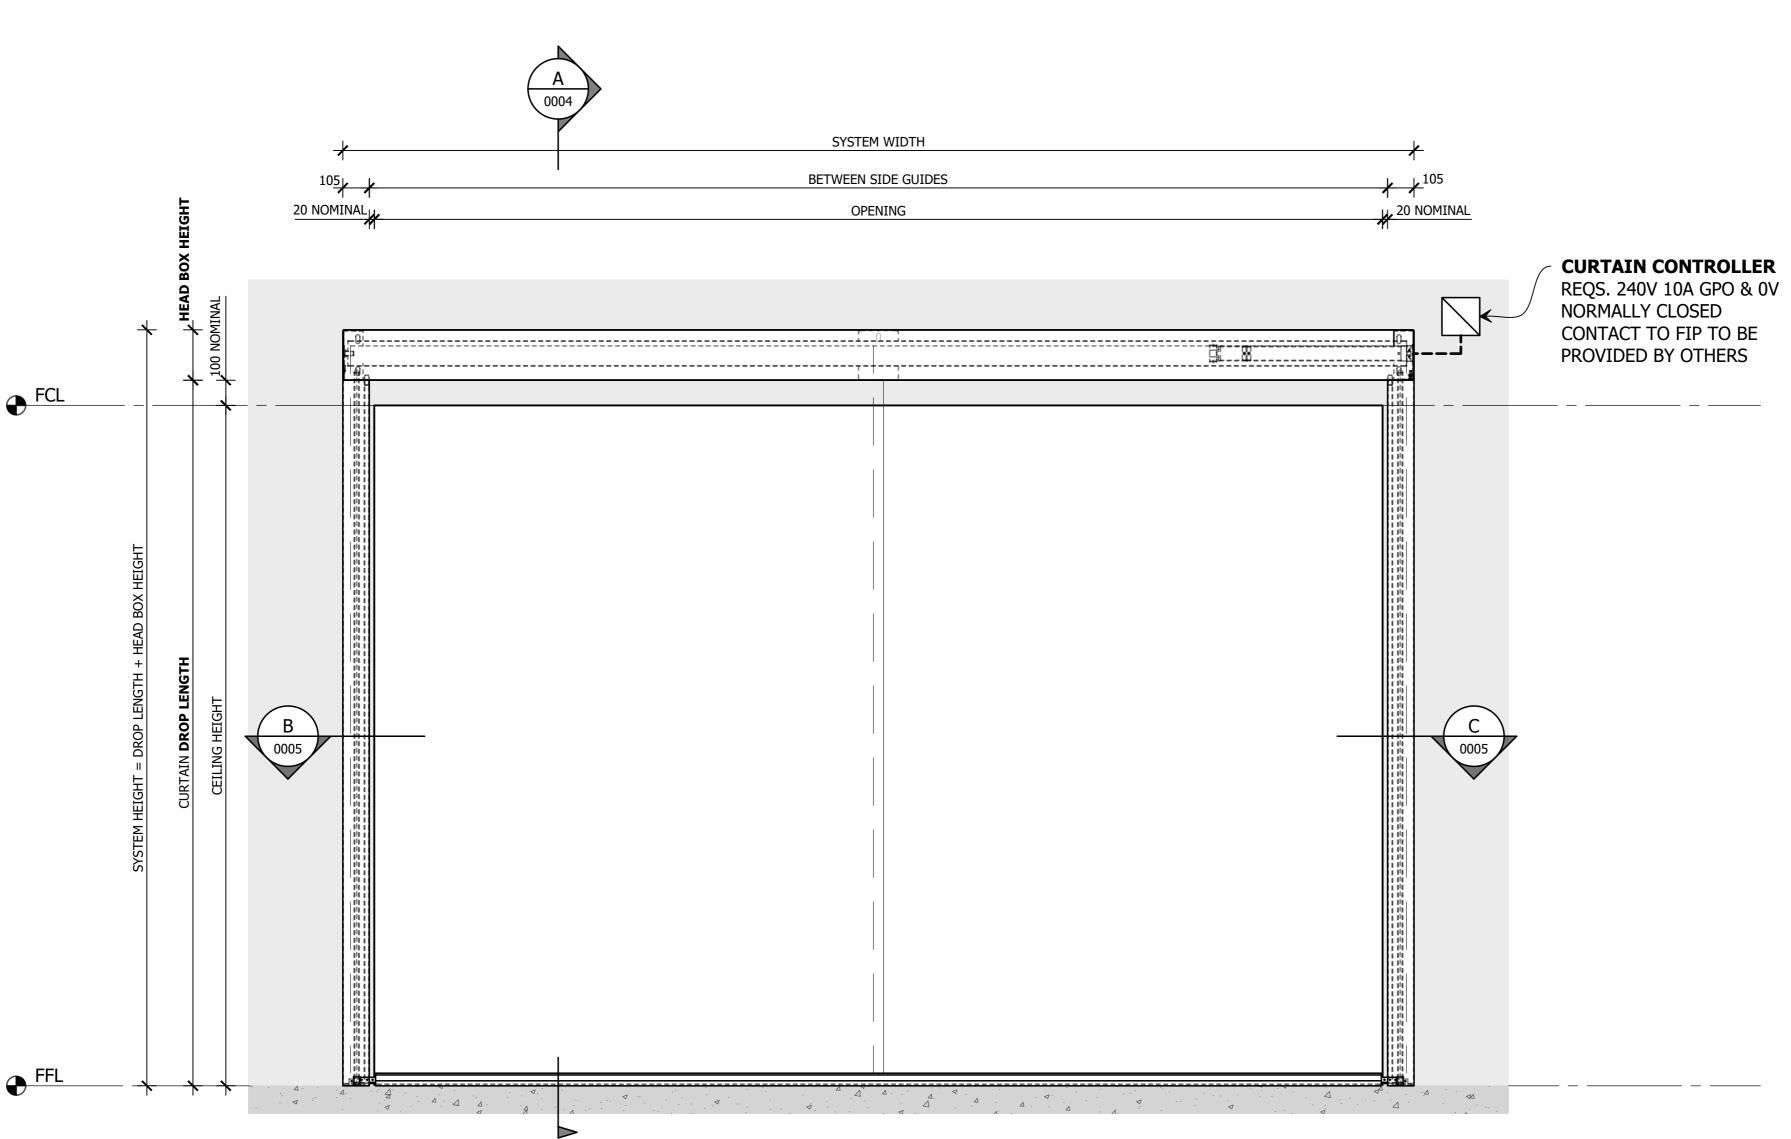

FIXED BEARING TYPE					
SYSTEM SIZE HEAD BOX SIZE					
SYSTEM WIDTH	DROP LENGTH	WIDTH	HEIGHT		
< 5,000	< 4,000	190	200		
< 5,000	> 3,500 ≤ 6,000	190	250		
< 5,000	> 6,000 ≤ 9,000	235	290		

FLOATING BEARING TYPE					
SYSTEM SIZE HEAD BOX SIZE					
SYSTEM WIDTH	DROP LENGTH	WIDTH	HEIGHT		
< 30,000	< 3,500	190	200		
< 30,000	> 3,500 ≤ 6,000	190	250		
< 20,000	$> 6,000 \le 9,000$	235	290		



THIS DRAWING IS COPYRIGHT AND THE PROPERTY OF THE AUTHOR, AND MUST NOT BE RETAINED, COPIED OR USED WITHOUT THE AUTHORITY OF SMOKE CONTROL SYSTEMS PTY. LTD.

01/09/2020

AC FOR APPROVAL

DO NOT SCALE FROM DRAWING, USE PROVIDED DIMENSIONS ONLY.
ALL DISCREPENCIES MUST BE BROUGHT TO THE ATTENTION OF AUTHOR.
SMOKE CONTROL SYSTEMS DO NOT TAKE RESPONSIBILITY OF MEASUREMENTS
PROVIDED BY OTHERS.

REASON DATE

DISCLAIMER

Information given in Smokecontrol.com.au and publications for Download are given to the best of our knowledge and IN GOOD FAITH. SMOKE CONTROL IS NOT RESPONSIBLE IF RECIPIENTS OF TEST REPORTS, ASSESSMENTS OR LITERATURE MISINTERPRET THE CONTENTS AND WRONGLY USE PRODUCTS BASED ON THOSE MISINTERPRETATIONS. NO LIABILITY IS ACCEPTED FOR ERROR OMISSIONS IN THIS WEB SITE OR OUR DOCUMENTS. IN THE INTERESTS OF IMPROVEMENTS AND CONTINUED DEVELOPMENT SMOKE CONTROL RESERVES THE RIGHT TO CHANGE SPECIFICATION

INFORMATION COPY ONLY



WWW.SMOKECONTROL.COM.AU WWW.SMOKECONTROL.CO.NZ WWW.SMOKECONTROL.COM

FIBERSHIELD V STANDARD TEMPLATE

AUSTRALIAN HEADOFFICE PHONE: 1300 665 471

PHONE: 09 300 1980 INFO@SMOKECONTROL.CO.NZ

CLIENT

PROJECT SCS-FSV

FRONT ELEVATION

SUB SET (CATEGORY) 00 - SPECIFICATIONS

DRAWING NUMBER

SCS-FSV-0003 DRAWN BY

ISSUE STATUS: FOR INFORMATION START DATE SCALE 01/09/2020 AS SHOWN

<<< 594mm

HEAD BOX MOUNTING OPTIONS:

< 5,000

< 5,000

 $> 3,500 \le 6,000$


 $> 6,000 \le 9,000$


190

235

250

290

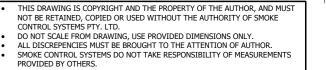

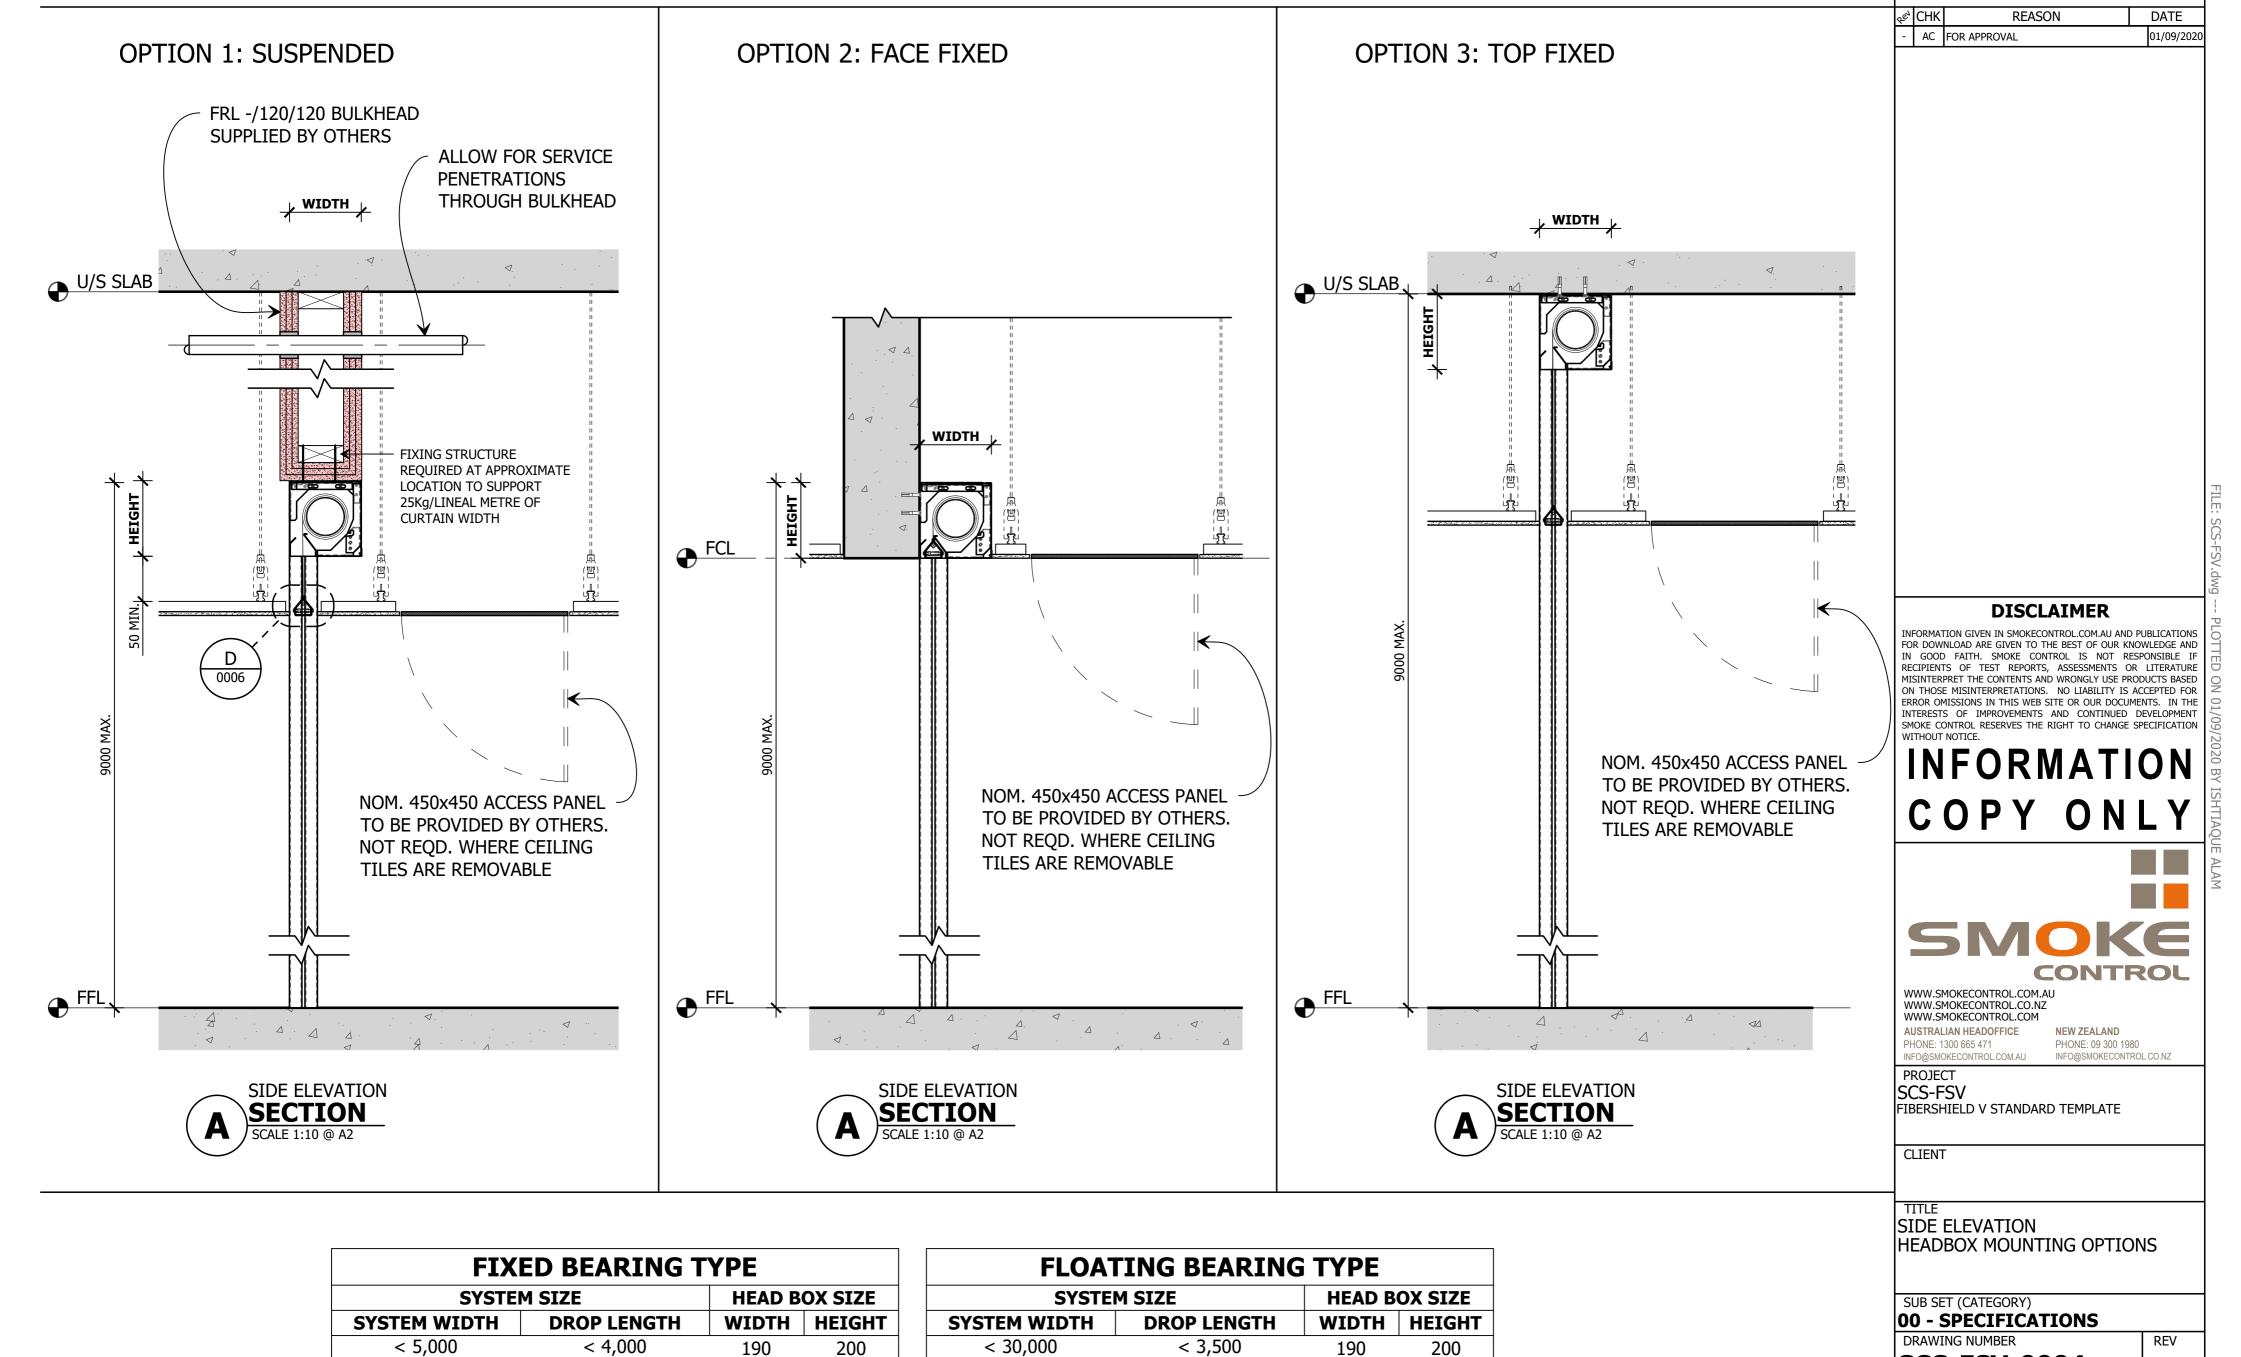

< 30,000

< 20,000

> 3,500 ≤ 6,000

 $> 6,000 \le 9,000$

250

290

190

235

@A2 5

ISSUE STATUS:

AS SHOWN

SCALE


FOR INFORMATION

SCS-FSV-0004


DRAWN BY

START DATE

01/09/2020

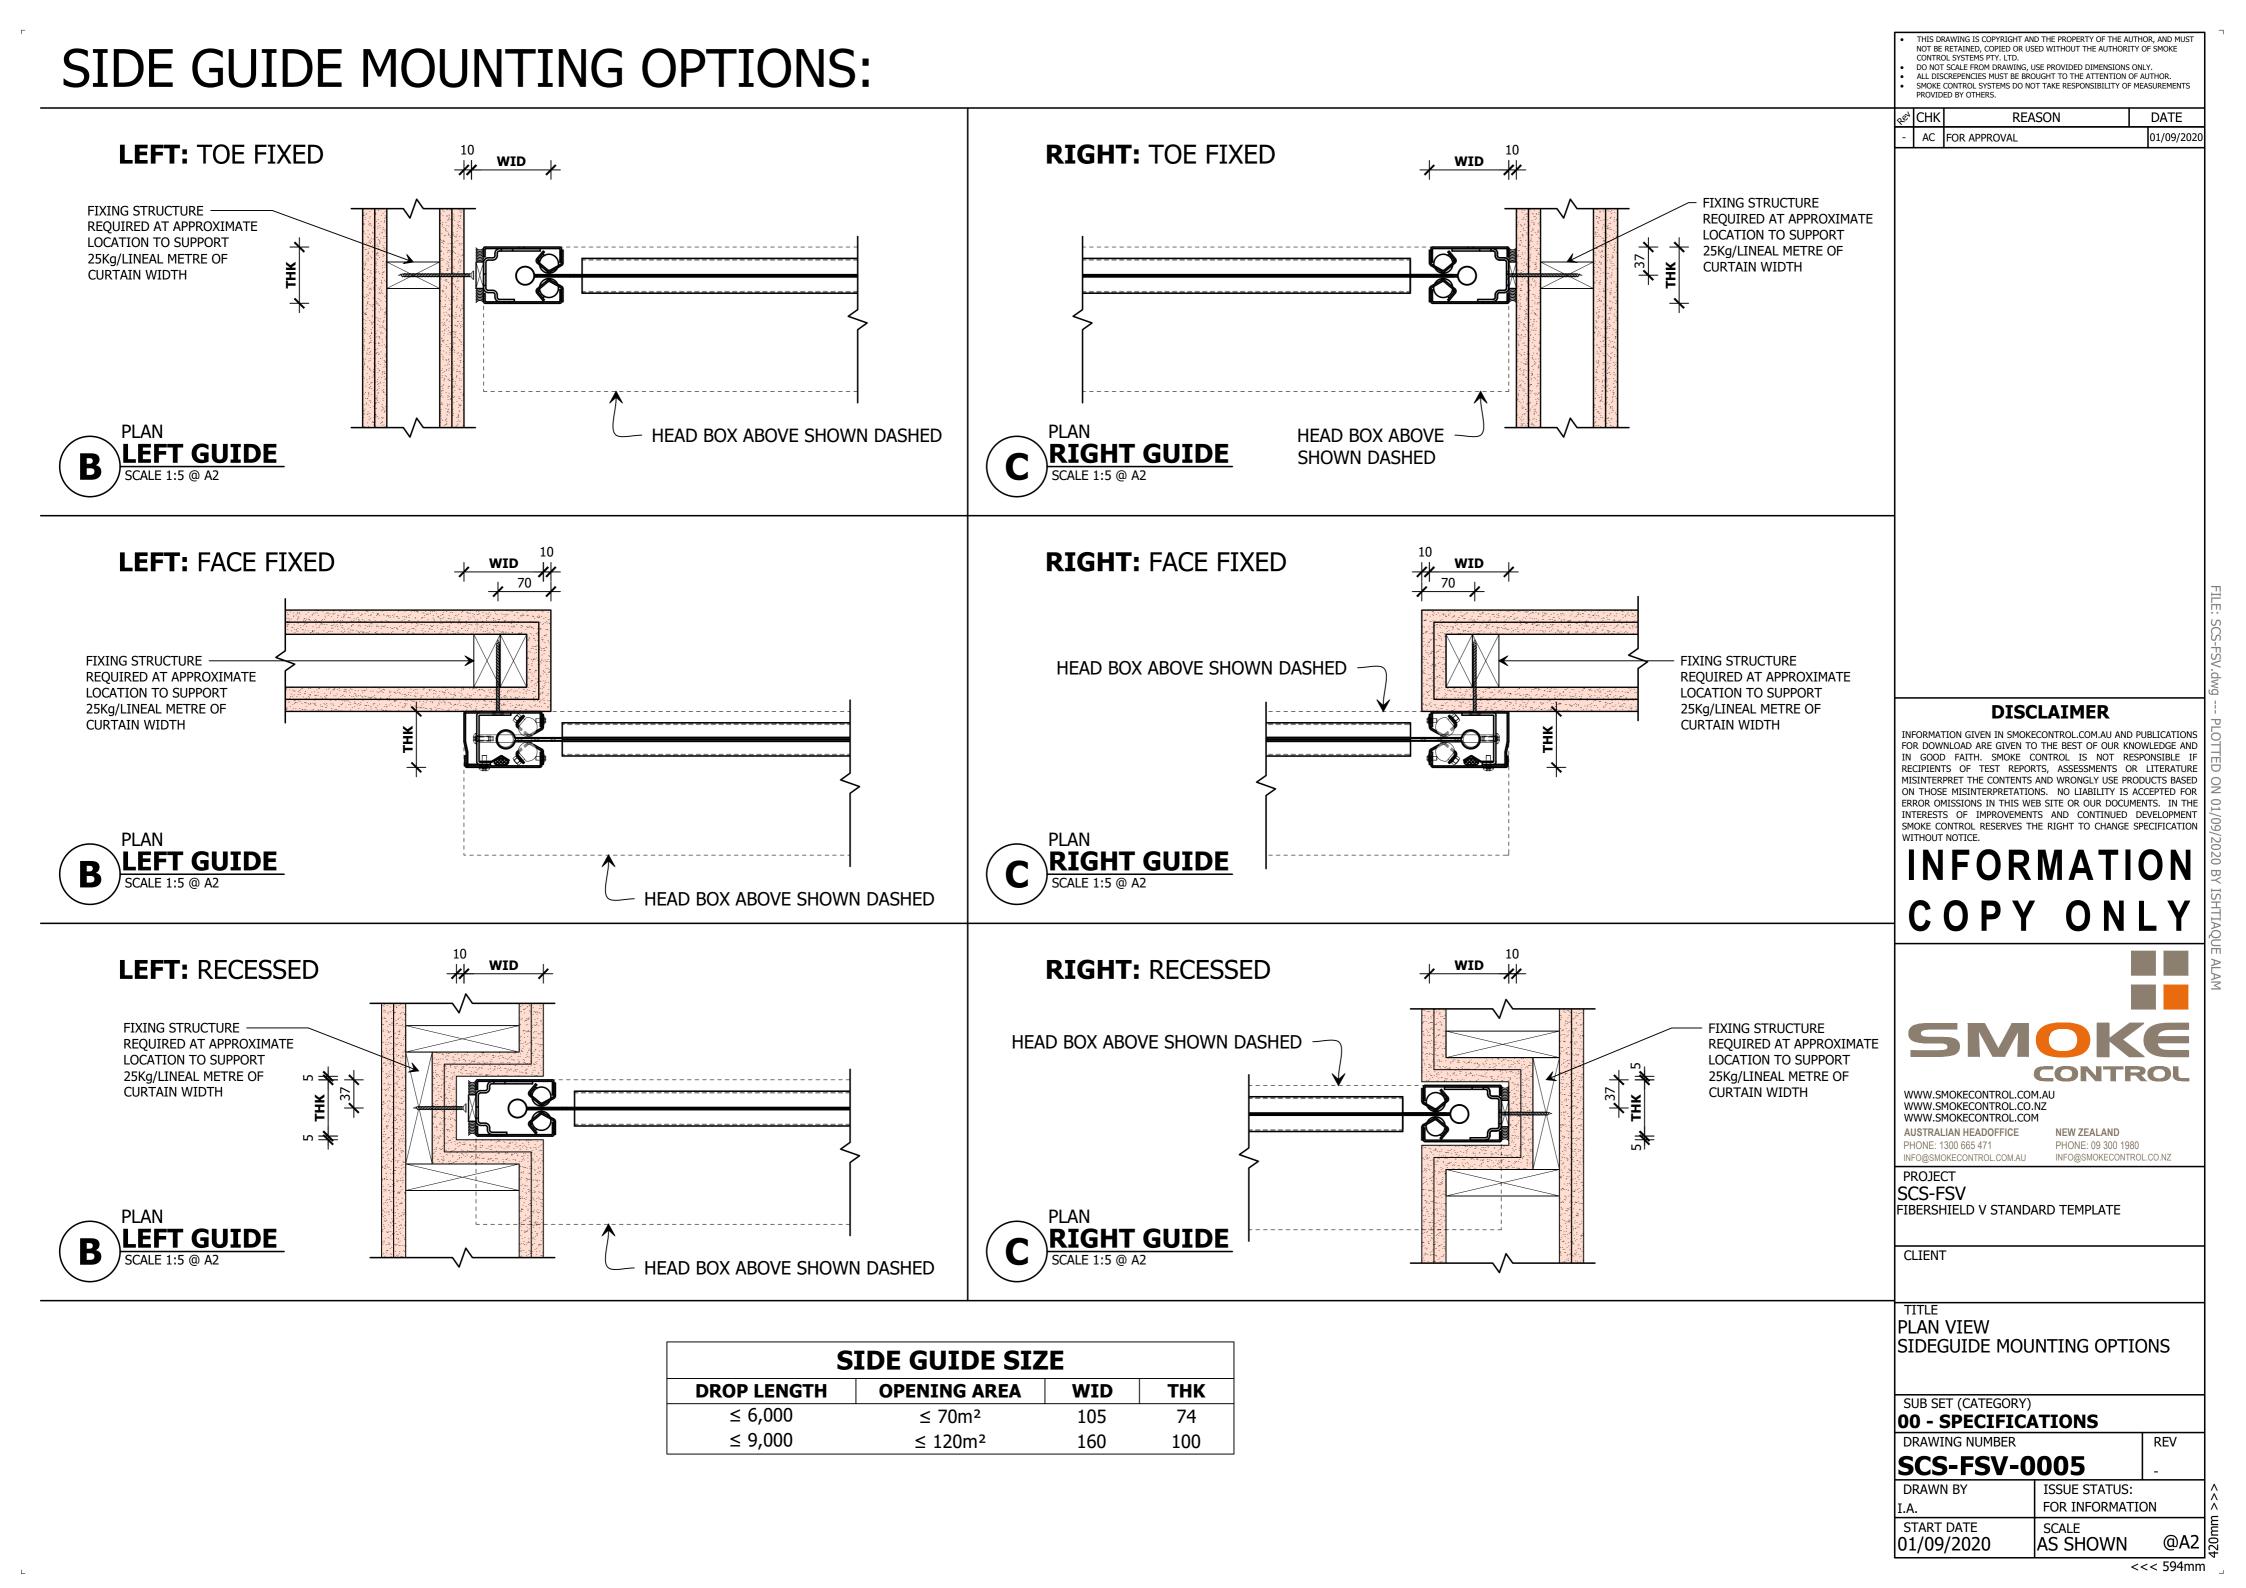

CORNER POST DETAIL:

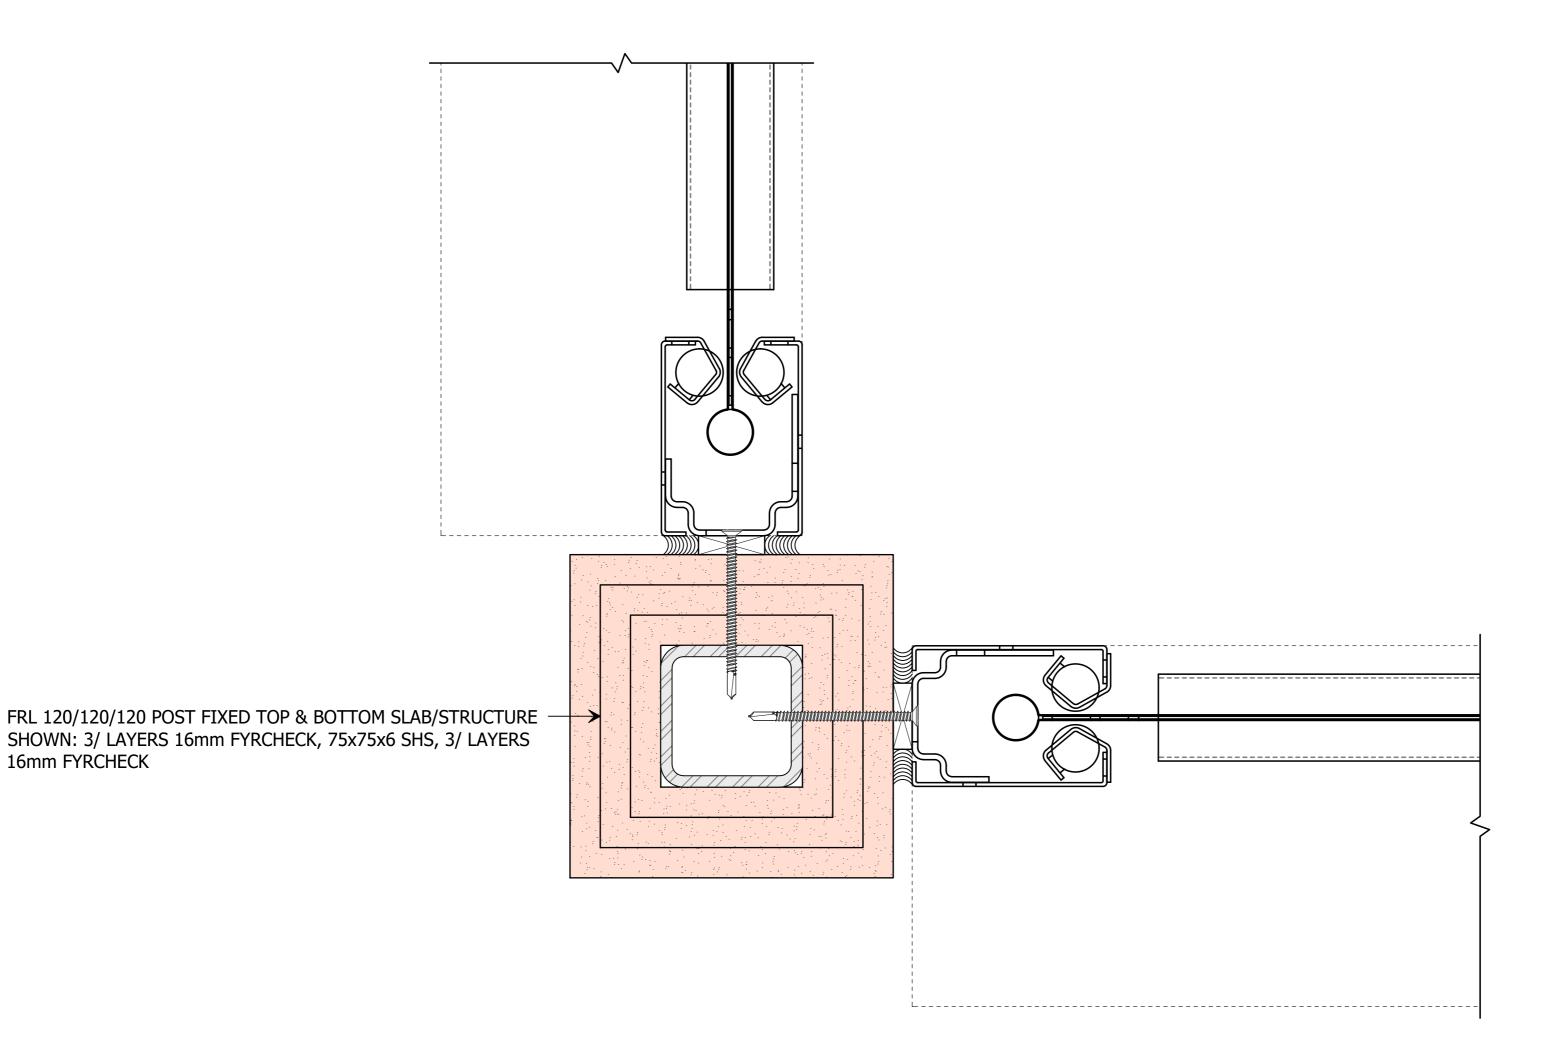

- THIS DRAWING IS COPYRIGHT AND THE PROPERTY OF THE AUTHOR, AND MUST NOT BE RETAINED, COPIED OR USED WITHOUT THE AUTHORITY OF SMOKE CONTROL SYSTEMS PTY. LTD.
- DO NOT SCALE FROM DRAWING, USE PROVIDED DIMENSIONS ONLY.
 ALL DISCREPENCIES MUST BE BROUGHT TO THE ATTENTION OF AUTHOR.
 SMOKE CONTROL SYSTEMS DO NOT TAKE RESPONSIBILITY OF MEASUREMENTS

REASON DATE AC FOR APPROVAL 01/09/2020

DISCLAIMER

Information given in Smokecontrol.com.au and publications for Download are given to the best of our knowledge and IN GOOD FAITH. SMOKE CONTROL IS NOT RESPONSIBLE IF RECIPIENTS OF TEST REPORTS, ASSESSMENTS OR LITERATURE MISINTERPRET THE CONTENTS AND WRONGLY USE PRODUCTS BASED ON THOSE MISINTERPRETATIONS. NO LIABILITY IS ACCEPTED FOR ERROR OMISSIONS IN THIS WEB SITE OR OUR DOCUMENTS. IN THE INTERESTS OF IMPROVEMENTS AND CONTINUED DEVELOPMENT SMOKE CONTROL RESERVES THE RIGHT TO CHANGE SPECIFICATION

INFORMATION COPY ONLY



WWW.SMOKECONTROL.COM.AU
WWW.SMOKECONTROL.CO.NZ WWW.SMOKECONTROL.COM

AUSTRALIAN HEADOFFICE PHONE: 1300 665 471

> PROJECT SCS-FSV

PHONE: 09 300 1980 INFO@SMOKECONTROL.CO.NZ

CLIENT

CORNER POST DETAIL

FIBERSHIELD V STANDARD TEMPLATE

SUB SET (CATEGORY) 00 - SPECIFICATIONS

DRAWING NUMBER

SCS-FSV-0006

DRAWN BY ISSUE STATUS:

START DATE SCALE AS SHOWN 01/09/2020 @**V**5

<<< 594mm

BOTTOM BAR OPTIONS:

STANDARD BOTTOM BAR


ELEVATION SECTION


BOTTOM BAR

SCALE 1:1 @ A2

SELF LEVELLING BOTTOM BAR FULLY CONCEALED

BOTTOM BAR SCALE 1:1 @ A2

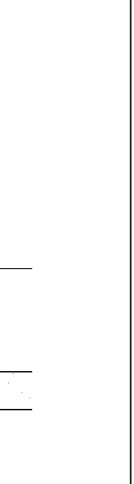

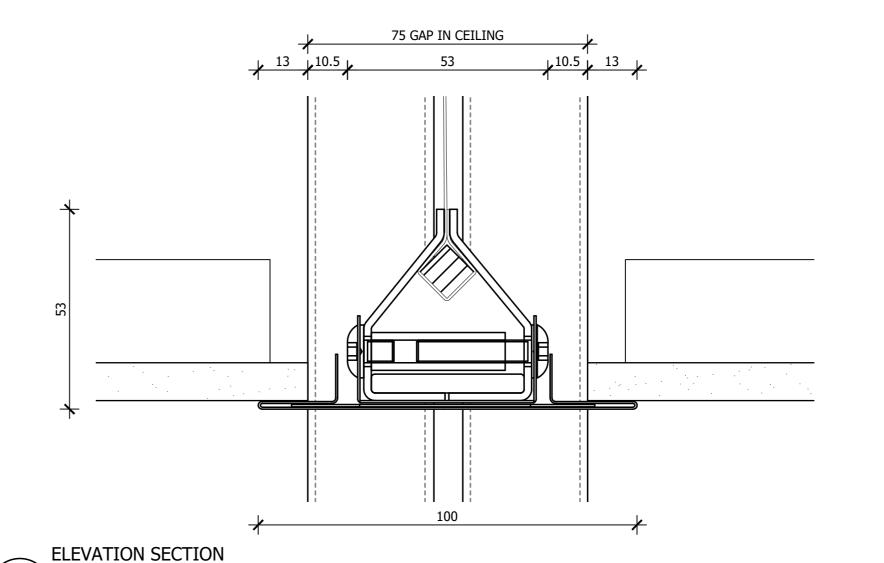

REASON DATE AC FOR APPROVAL 01/09/2020

THIS DRAWING IS COPYRIGHT AND THE PROPERTY OF THE AUTHOR, AND MUST NOT BE RETAINED, COPIED OR USED WITHOUT THE AUTHORITY OF SMOKE

DO NOT SCALE FROM DRAWING, USE PROVIDED DIMENSIONS ONLY.
ALL DISCREPENCIES MUST BE BROUGHT TO THE ATTENTION OF AUTHOR.
SMOKE CONTROL SYSTEMS DO NOT TAKE RESPONSIBILITY OF MEASUREMENTS

CONTROL SYSTEMS PTY. LTD.

DISCLAIMER

INFORMATION GIVEN IN SMOKECONTROL.COM.AU AND PUBLICATIONS FOR DOWNLOAD ARE GIVEN TO THE BEST OF OUR KNOWLEDGE AND IN GOOD FAITH. SMOKE CONTROL IS NOT RESPONSIBLE IF RECIPIENTS OF TEST REPORTS, ASSESSMENTS OR LITERATURE MISINTERPRET THE CONTENTS AND WRONGLY USE PRODUCTS BASED ON THOSE MISINTERPRETATIONS. NO LIABILITY IS ACCEPTED FOR ERROR OMISSIONS IN THIS WEB SITE OR OUR DOCUMENTS. IN THE INTERESTS OF IMPROVEMENTS AND CONTINUED DEVELOPMENT SMOKE CONTROL RESERVES THE RIGHT TO CHANGE SPECIFICATION

INFORMATION COPY ONLY



WWW.SMOKECONTROL.COM.AU WWW.SMOKECONTROL.CO.NZ WWW.SMOKECONTROL.COM

AUSTRALIAN HEADOFFICE PHONE: 1300 665 471

PHONE: 09 300 1980 INFO@SMOKECONTROL.CO.NZ

CLIENT

PROJECT SCS-FSV

BOTTOM BAR OPTIONS

FIBERSHIELD V STANDARD TEMPLATE

SUB SET (CATEGORY)


00 - SPECIFICATIONS

DRAWING NUMBER

01/09/2020

SCS-FSV-0007 DRAWN BY ISSUE STATUS: FOR INFORMATION START DATE SCALE

AS SHOWN <<< 594mm

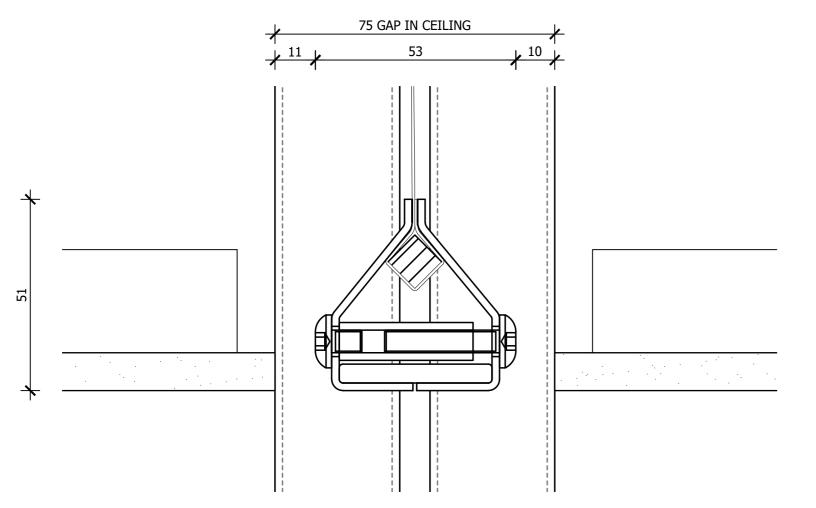

IRS40 OBSTRUCTION SENSORS

PROTECT YOUR ASSET FROM DAMAGE CAUSED BY OBSTRUCTIONS AND ENSURE FULL DEPLOYMENT OF YOUR FIRE AND SMOKE CURTAIN SYSTEM AND THEREFORE FULL COMPLIANCE WITH THE FIRE ENGINEERS REPORT.

ELIMINATE THE REQUIREMENT FOR LINE MARKINGS AND MULTI-COLOURED EXCLUSION ZONES WHICH DETRACT FROM THE INTERIOR DESIGN! THE AUTOMATED IRS40 IS SUITABLE FOR USE ON ALL OF SMOKE CONTROL'S FIRE AND SMOKE CURTAIN SYSTEMS.


OTHER SENSOR SYSTEMS CAN REGISTER SMOKE AS AN OBSTRUCTION AND PREVENT DEPLOYMENT OF THE BARRIER WHEN IT IS ACTUALLY REQUIRED AND CONFLICT WITH THE INTENT OF THE ALTERNATIVE SOLUTION.


THE IRS40 SENSOR SYSTEM IS UNIQUE AND WILL NOT CAUSE THIS CONFLICT, ALLOWING THE BARRIER TO BOTH OPERATE AS INTENDED AND MAINTAIN COMPLIANCE WITH THE PERFORMANCE SOLUTION AT ALL TIMES.


WHEN A OBSTRUCTION IS DETECTED UNDER THE DEPLOYMENT AREA OF THE BARRIER, THE SYSTEM WILL WAIT FOR A SPECIFIED TIME DELAY, THEN AN AUDIO-VISUAL SIGNAL WILL NOTIFY THE OCCUPANTS THAT THE OBSTRUCTION MUST BE REMOVED. THE SYSTEM AUTOMATICALLY RESETS ONCE THE OBSTRUCTION IS REMOVED FROM THE DEPLOYMENT AREA.


DIMENSIONS: 230mm (W), 70mm (H), 44mm (D)


IP RATING: IP54

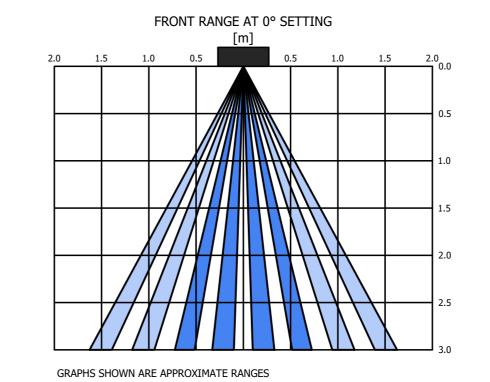

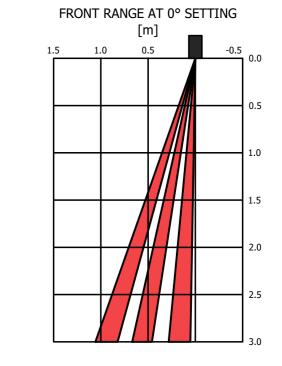

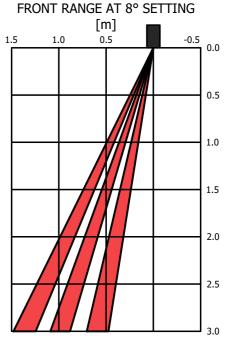

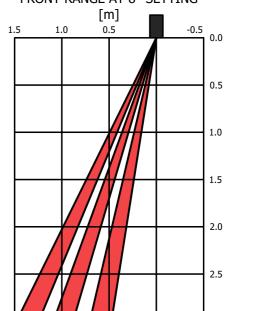

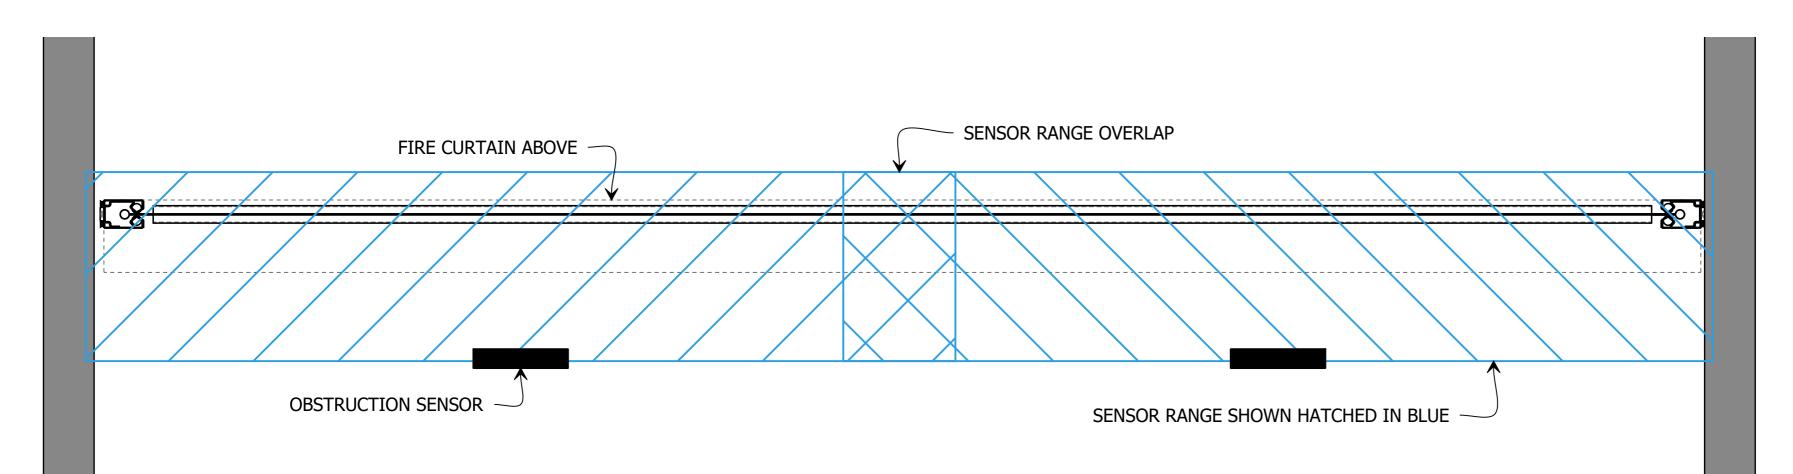



DISCLAIMER

NOT BE RETAINED, COPIED OR USED WITHOUT THE AUTHORITY OF SMOKE

DO NOT SCALE FROM DRAWING, USE PROVIDED DIMENSIONS ONLY.
ALL DISCREPENCIES MUST BE BROUGHT TO THE ATTENTION OF AUTHOR. SMOKE CONTROL SYSTEMS DO NOT TAKE RESPONSIBILITY OF MEASUREMENTS

REASON

DATE

01/09/2020

CONTROL SYSTEMS PTY. LTD.

AC FOR APPROVAL

INFORMATION GIVEN IN SMOKECONTROL.COM.AU AND PUBLICATIONS FOR DOWNLOAD ARE GIVEN TO THE BEST OF OUR KNOWLEDGE AND IN GOOD FAITH. SMOKE CONTROL IS NOT RESPONSIBLE RECIPIENTS OF TEST REPORTS, ASSESSMENTS OR LITERATURE MISINTERPRET THE CONTENTS AND WRONGLY USE PRODUCTS BASED ON THOSE MISINTERPRETATIONS. NO LIABILITY IS ACCEPTED FOR ERROR OMISSIONS IN THIS WEB SITE OR OUR DOCUMENTS. IN THE INTERESTS OF IMPROVEMENTS AND CONTINUED DEVELOPMENT SMOKE CONTROL RESERVES THE RIGHT TO CHANGE SPECIFICATION

INFORMATION COPY ONLY



WWW.SMOKECONTROL.COM.AU WWW.SMOKECONTROL.CO.NZ WWW SMOKECONTROL COM

PHONE: 1300 665 471

PHONE: 09 300 1980

PROJECT SCS-FSV FIBERSHIELD V STANDARD TEMPLATE

CLIENT

OBSTRUCTION SENSORS

SUB SET (CATEGORY)

DRAWING NUMBER

00 - SPECIFICATIONS

SCS-FSV-0008

ISSUE STATUS: DRAWN BY FOR INFORMATION START DATE SCALE AS SHOWN 01/09/2020

<<< 594mm